


three inches = one foot
one and one-half inches = one foot
one inch = one foot
three-quarters inch = one foot
one-half inch = one foot
three-eighths inch = one foot
one-quarter inch = one foot
one-eighth inch = one foot

- NOTES:**
(THIS SHEET ONLY)
- 1 OLD DIMMING SYSTEM ADJACENT TO PANEL DN-2 SHALL BE COMPLETELY REMOVED.
 - 2 RELOCATE NEUTRAL TO NEUTRAL BUS TO REMOVE NEUTRAL BOND WITH ENCLOSURE. PROVIDE A NEW GROUND BAR AND RELOCATE ALL GROUND CONDUCTORS TO NEW GROUND BAR.
 - 3 REWORK GROUND AND NEUTRAL CONDUCTORS SO THAT GROUNDS ARE ON GROUND BUS AND NEUTRAL CONDUCTORS ARE ON NEUTRAL BUS.
 - 4 PROVIDE A NEW GROUND BAR IN PANEL AND RELOCATE ALL GROUND CONDUCTOR TO NEW GROUND BAR.
 - 5 REMOVE CONDUCTORS FROM PANEL "DN-2" TO FLOOR POCKETS AT FRONT OF STAGE. PROVIDE PULL CORD IN REMAINING CONDUIT FOR FUTURE USE. REMOVE ALL OLD EQUIPMENT FROM FLOOR POCKETS.
 - 6 EXISTING FLUSH MOUNTED ELECTRICAL PANEL TO BE REPLACED. CONTRACTOR SHALL DISCONNECT AND REMOVE EXISTING PANEL, LEAVING ALL EXISTING BRANCH CIRCUITS "AS-IS" FOR RECONNECTION TO NEW PANEL TO BE INSTALLED IN SAME LOCATION. MAKE ALL CONNECTIONS AND EXTEND ALL CIRCUITS AS REQUIRED. SEE PANELBOARD SCHEDULE FOR CIRCUITS TO BE RECONNECTED.
 - 7 EXISTING PANEL PK-L1 TO BE REMOVED COMPLETELY AND EXISTING BRANCH CIRCUITS RE-ROUTED TO NEW PANEL 2LNB1-R. SEE PANELBOARD SCHEDULE 2LNB1-R FOR CIRCUITS TO BE RELOCATED. INTERCEPT EXISTING CIRCUITS AND EXTEND AS REQUIRED.
 - 8 EXISTING SURFACE MOUNTED ELECTRICAL PANEL TO BE REPLACED. CONTRACTOR SHALL DISCONNECT AND REMOVE EXISTING PANEL, LEAVING ALL EXISTING BRANCH CIRCUITS "AS-IS" FOR RECONNECTION TO NEW PANEL TO BE INSTALLED IN SAME LOCATION. MAKE ALL CONNECTIONS AND EXTEND ALL CIRCUITS AS REQUIRED. SEE PANELBOARD SCHEDULE FOR CIRCUITS TO BE RECONNECTED.
 - 9 REMOVE GUTTER LOCATED IN CLOSET. RELOCATE EXISTING BRANCH CIRCUITS TO NEAREST PANELBOARD.

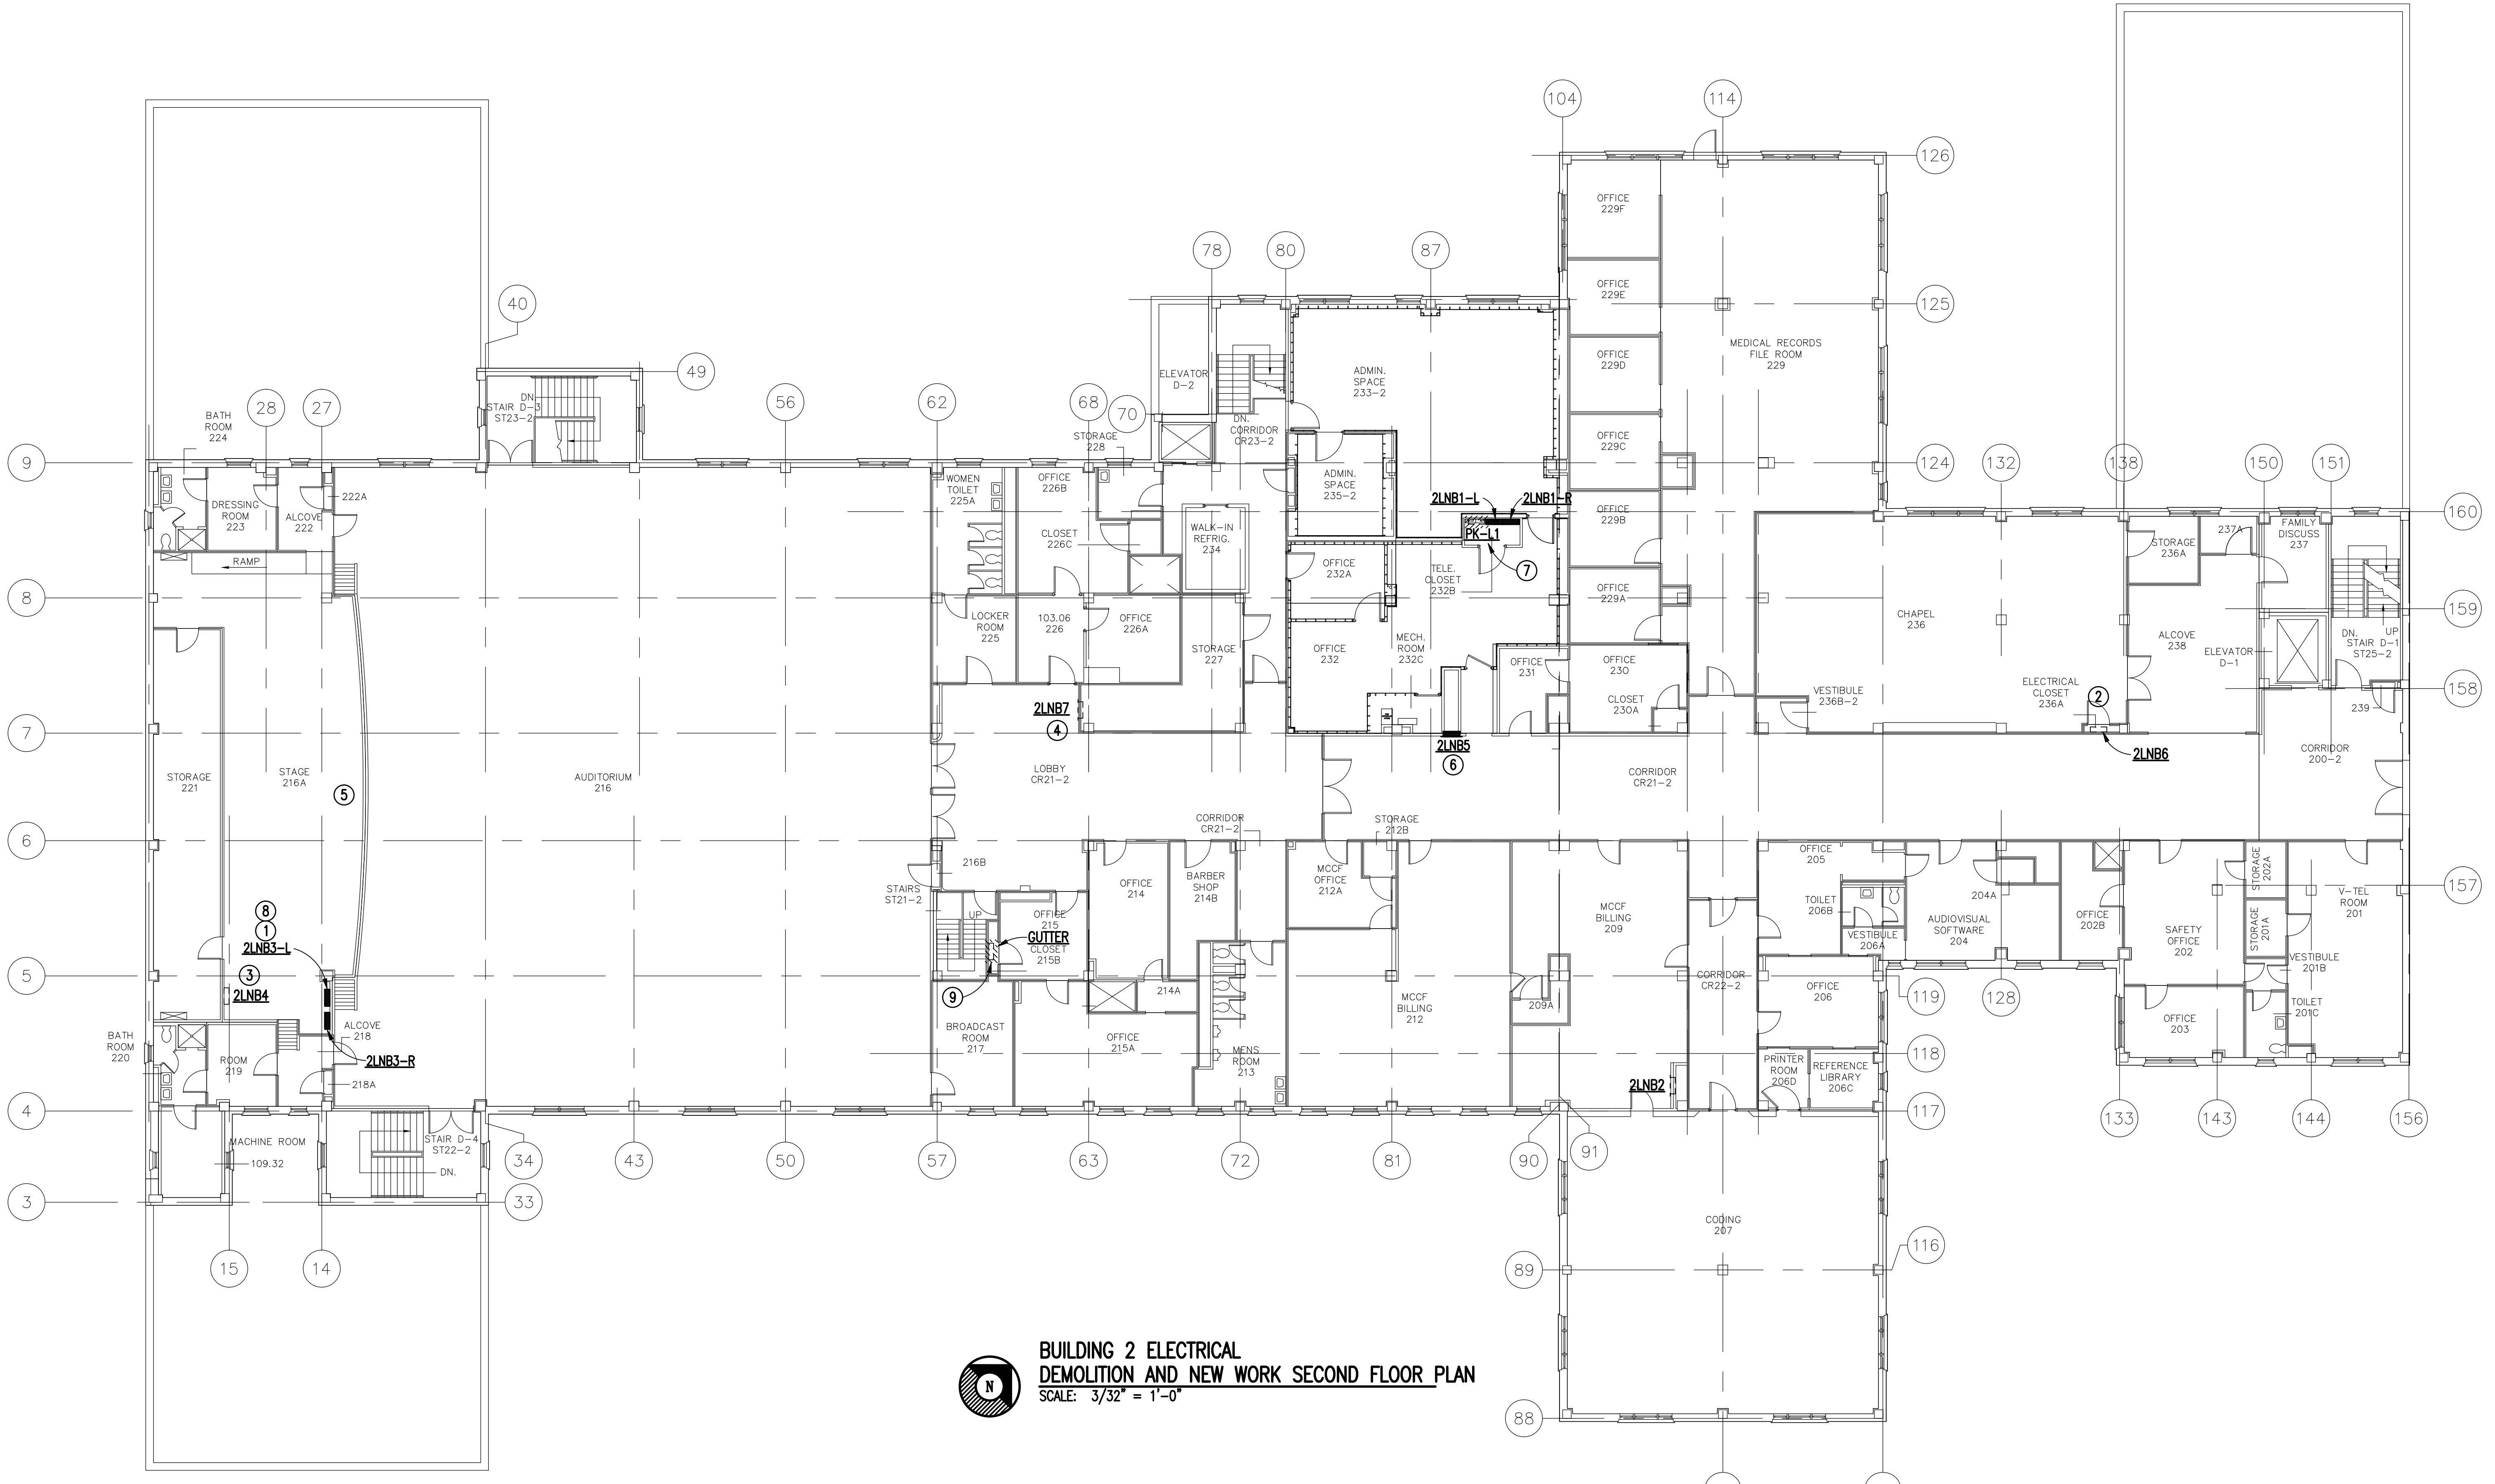

**BUILDING 2 ELECTRICAL
DEMOLITION AND NEW WORK SECOND FLOOR PLAN**
SCALE: 3/32" = 1'-0"

Revisions 	TOLAND • MIZELL APPLIED ENGINEERING SOLUTIONS, INC. <i>Joint Venture</i>			Drawing Title BUILDING 2 ELECTRICAL DEMOLITION AND NEW WORK SECOND FLOOR PLAN		Project Title CORRECT ELECTRICAL DEFICIENCIES		Date FEBRUARY 2, 2012			
				Approved Project Director		Building Number 2		Checked RBP	Drawn TWG	Project No. 557-10-110	
				FINAL SUBMITTAL		Location CARL VINSON VA MEDICAL CENTER DUBLIN, GEORGIA		Drawing No. 2-ES1.3		Dwg. Of	

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